DEVELOPMENT APPLICATION

ALTERATIONS AND ADDITIONS

AT

61 TURTON AVE, CLEMTON PARK

FOR

Mr. & Mrs. KAROZIS

ARCHITECTURAL DRAWING LIST

Sheet No.

Sheet Name

- **EXISTING SITE PLAN**
- **EXISTING FLOOR PLANS**
- PROPOSED DEMOLITION PLAN 03
- PROPOSED SITE PLAN
- PROPOSED GROUND FLOOR PLAN 05
- PROPOSED ROOF PLAN
- PROPOSED SOUTH & WEST ELEVATIONS 07
- 80 PROPOSED NORTH & EAST ELEVATIONS
- 09 PROPOSED SECTION
- 10 PROPOSED OUTBUILDING PLAN & SECTIONS
- 11 PROPOSED OUTBUILDING ELEVATIONS
- 12 DOOR & WINDOW SCHEDULE
- 13 AREA CALCULATIONS
- 14 SEDIMENT CONTROL, CONSTRUCTION & WASTE MANAGEMENT PLAN
- 15 SITE & CONTEXT ANALYSIS PLAN
- 16 FINISHES SCHEDULE
- 17 PEG-OUT
- BASIX
- **PERSPECTIVES**



В	DEVELOPMENT APPLICATION	17/06/2025	DP	EJS, RO
Α	CONCEPT DESIGN - SIGN-OFF	21/05/2025	DP	EJS, RO
ISSUE	AMENDMENTS	DATE	DRN	CHK
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Mr. & Mrs. KAROZIS

PARK

61 TURTON AVE, CLEMTON

ALTERATIONS AND ADDITIONS

DEVELOPMENT APPLICATION

В SHEET NO: 00 888-1815 DESIGN: DP CHECKED BY: EJS. RO

COVER SHEET

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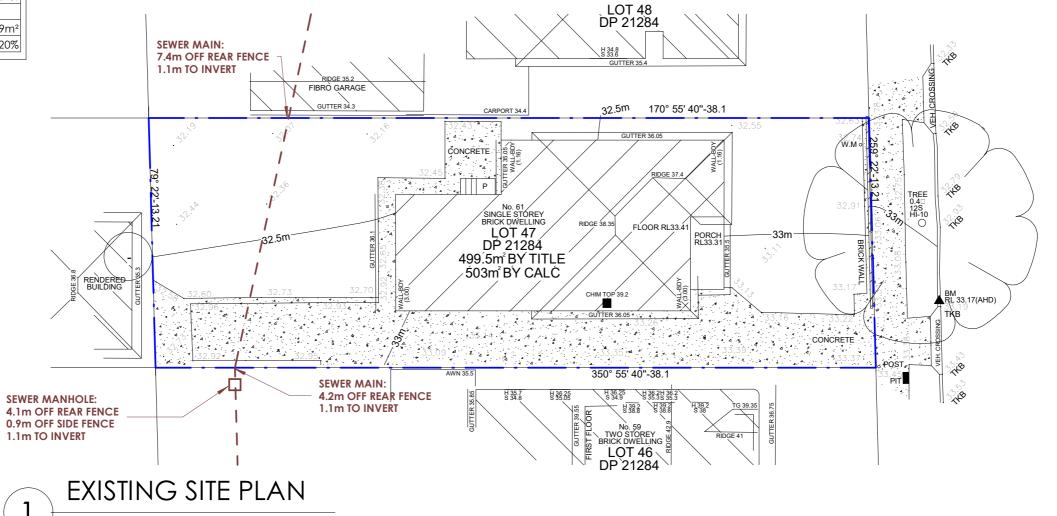
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ZONE	R2
SITE AREA	499.5m²
FLOOR AREA	
EXISTING DWELLING	118.29m²
OUTBUILDINGS/GARAGE	20.79m²
EXISTING FSR	0.24:1
MAX PERMISSIBLE	0.5:1
SITE COVERAGE	
HARD STAND AREA	137.97m²
SOFT LANDSCAPE AREA	13.58m²
DEEP SOIL AREA	199.24m²
DEEP SOIL %	39%
MIN. DEEP SOIL AREA	99.9m²
MIN. DEEP SOIL % REQUIRED	20%

NOTE: SURVEY INFORMATION AND LEVELS ARE EXTRACTED FROM SURVEY PLAN PREPARED BY REGISTERED SURVEYOR "TJ SURVEYORS PTY LTD" FILE No. 15563

REFER TO PEG-OUT PREPARED BY ALL SYDNEY SIDE LINES PTY LTD FOR FURTHER INFORMATION **SUPPLIER No: 1165**





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1:200

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ALTERATIONS AND ADDITIONS

DEVELOPMENT APPLICATION

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EXISTING SITE PLAN

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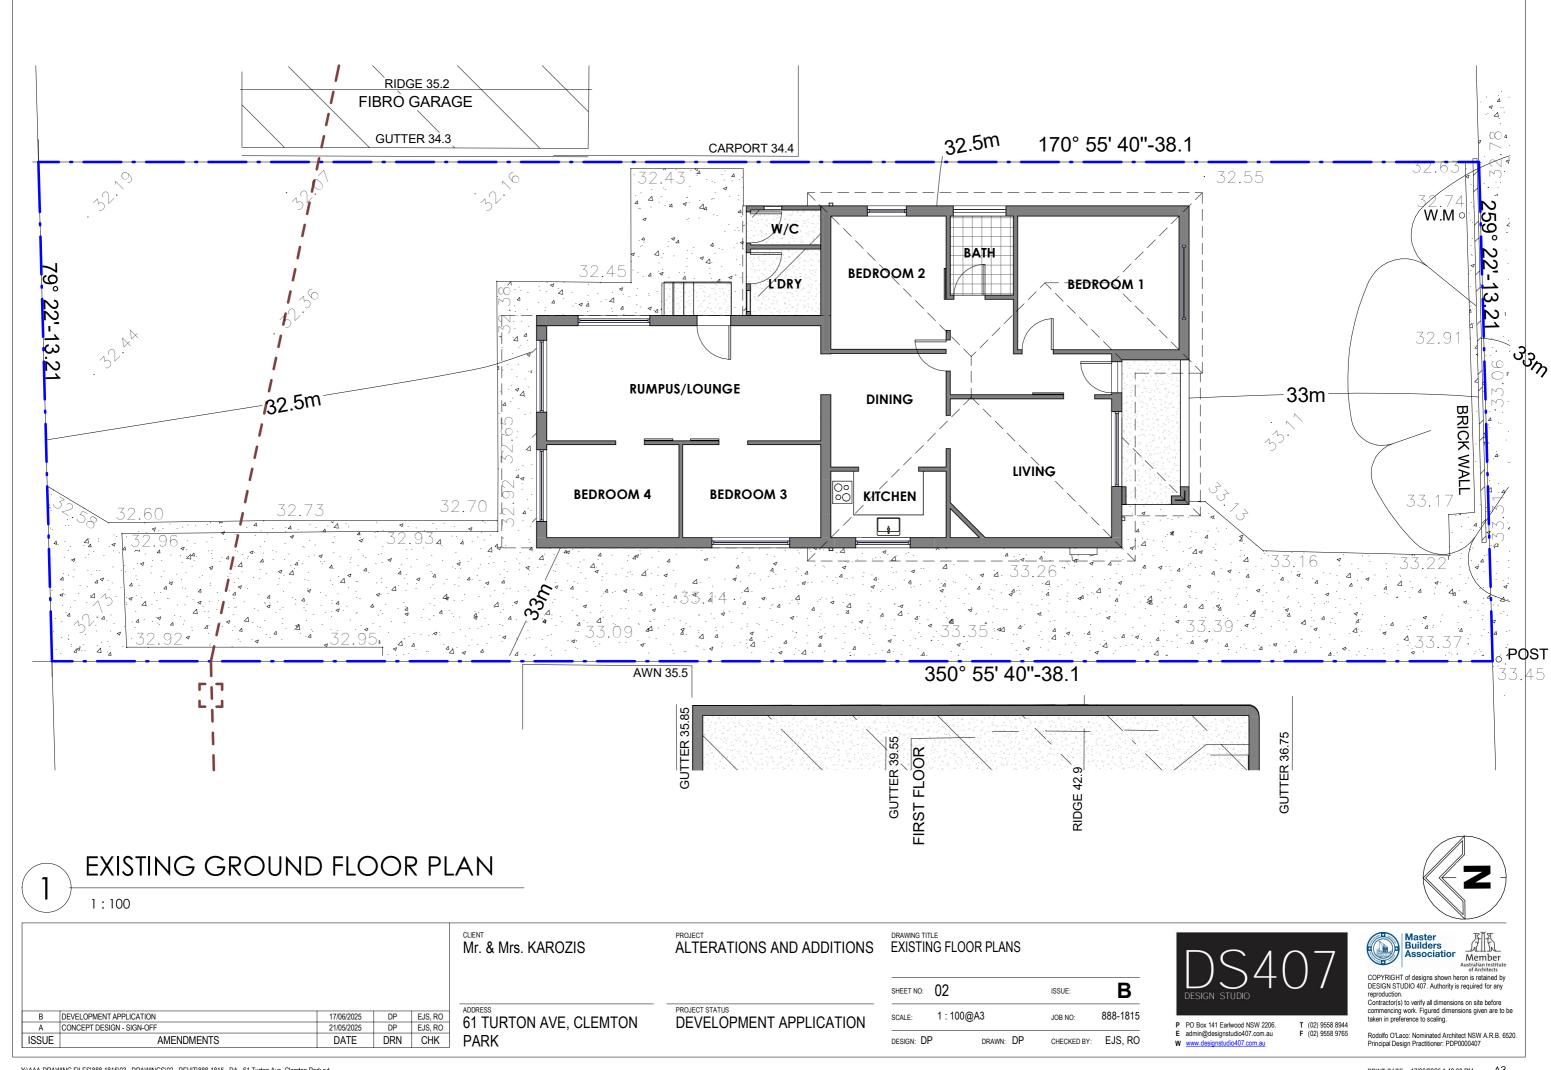
AVENUE


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SITE CALCULATIONS **ALTERATIONS & ADDITIONS** ZONE R2 SITE AREA 499.5m² **FLOOR AREA** EXISTING DWELLING 118.29m² PROPOSED ADDITIONS PROPOSED GROUND FLOOR 22.01m² TOTAL FLOOR AREA 140.3m² TOTAL FSR 0.28:1 MAX PERMISSIBLE 0.5:1 SITE COVERAGE PROPOSED DWELLING FOOTPRINT 156m² 34.73m² OUTBUILDINGS HARD STAND AREA 122.7m² SOFT LANDSCAPE AREA 23.52m² DEEP SOIL AREA 165.97m² DEEP SOIL % 33% MIN. DEEP SOIL AREA 99.9m² MIN. DEEP SOIL % REQUIRED 20%

SELECT ROOF SHEETING AT 1° FALL


SEWER MAIN:

1.1m TO INVERT

1.1m TO INVERT

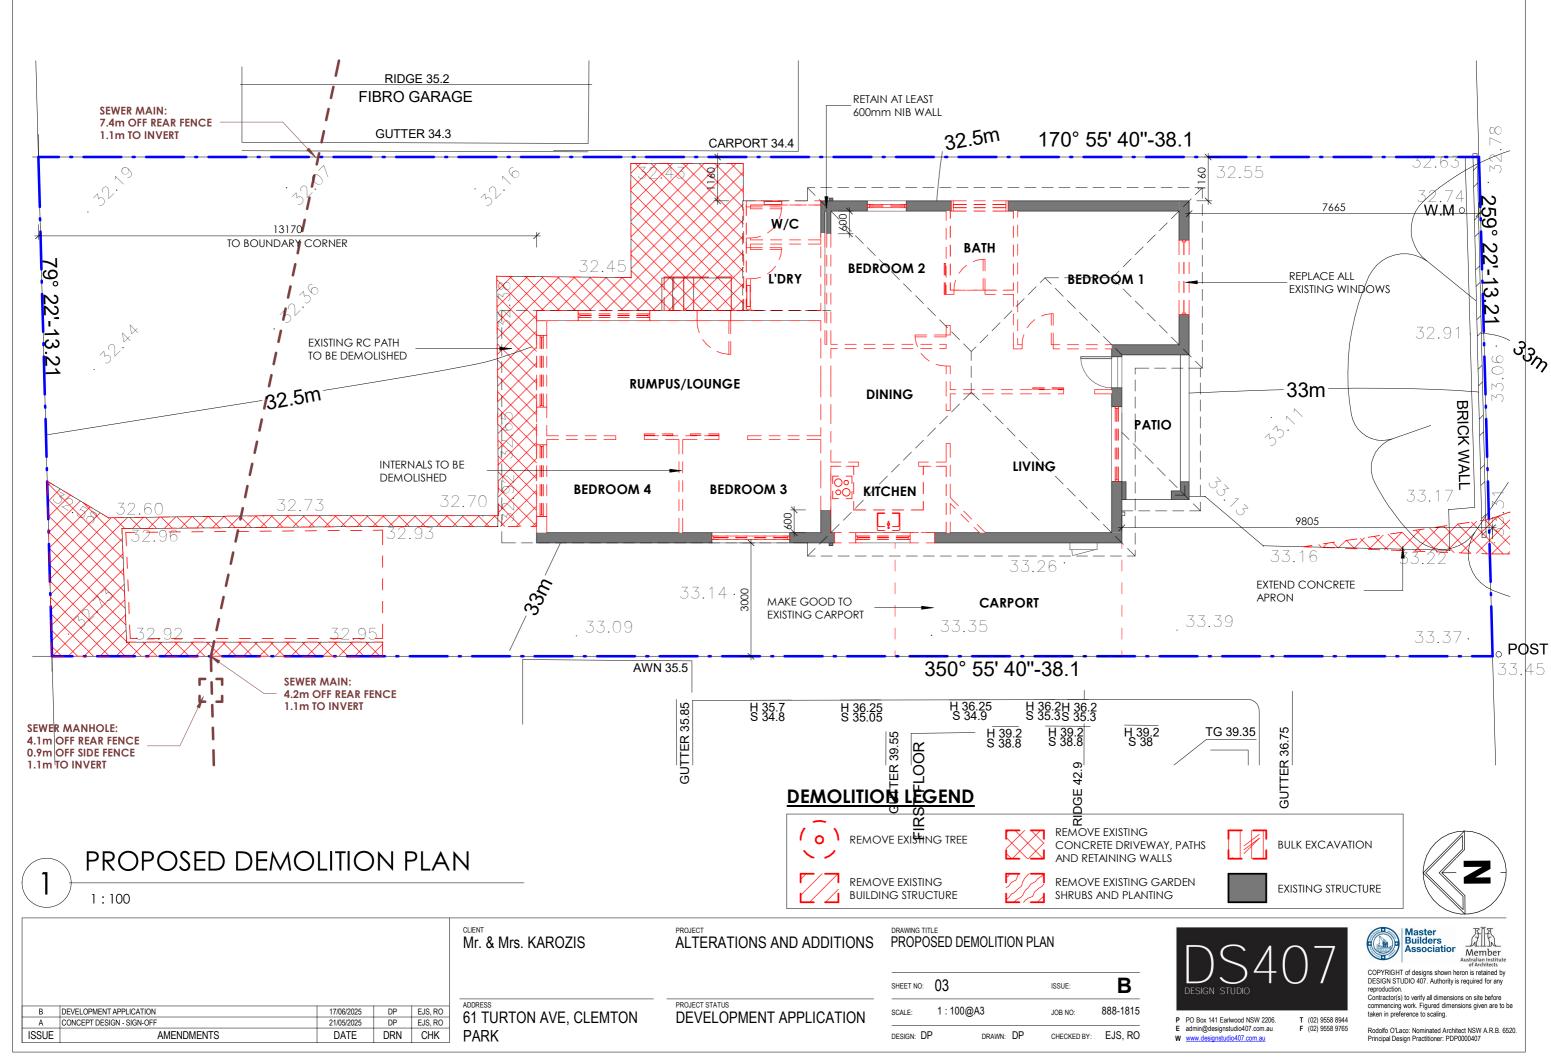GENERAL NOTES:

- BRICK VENEER WALL CONSTRUCTION TO REAR EXTENSION & OUTBUILDING
- TIMBER FLOOR CONSTRUCTION TO REAR EXTENSIONS AS PER AS 1684
- RC SLAB & FOOTINGS TO OUTBUILDING EXTENSION AS PER ENGINEER'S DETAILS
- PROVIDE ADEQUATE FALL TO FLOOR WASTE IN ALL WET AREAS
- PROVIDE ADEQUATE WATER PROOFING TO ALL WET AREAS
- TIMBER FRAME ROOF CONSTRUCTION AS PER AS 1684
- ALUMINIUM COLORBOND FASCIAS, GUTTERS & DOWNPIPES CONNECTED TO STORMWATER SYSTEM AS PER ENGINEER'S DETAILS
- ALUMINIUM POWDER COATED WINDOWS & DOOR ASSEMBLIES
- REFER TO BASIX FOR GLAZING SPECIFICATIONS
- REFER TO BASIX FOR THERMAL & WATER SPECIFICATIONS

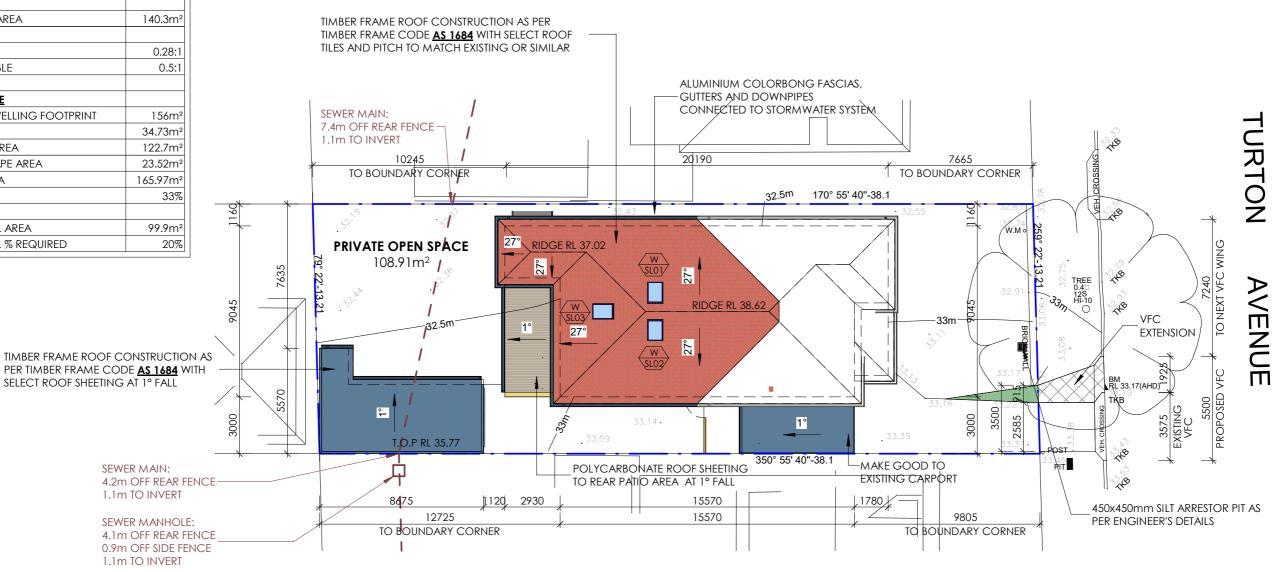





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B A	DEVELOPMENT APPLICATION CONCEPT DESIGN - SIGN-OFF	17/06/2025 21/05/2025	DP DP	EJS, RO

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ALTERATIONS AND ADDITIONS

SHEET NO: 04 ISSUE: SCALE: 1:200@A3 JOB NO: 888-1815 **DEVELOPMENT APPLICATION** DESIGN: DP DRAWN: DP CHECKED BY: EJS. RO

PROPOSED SITE PLAN




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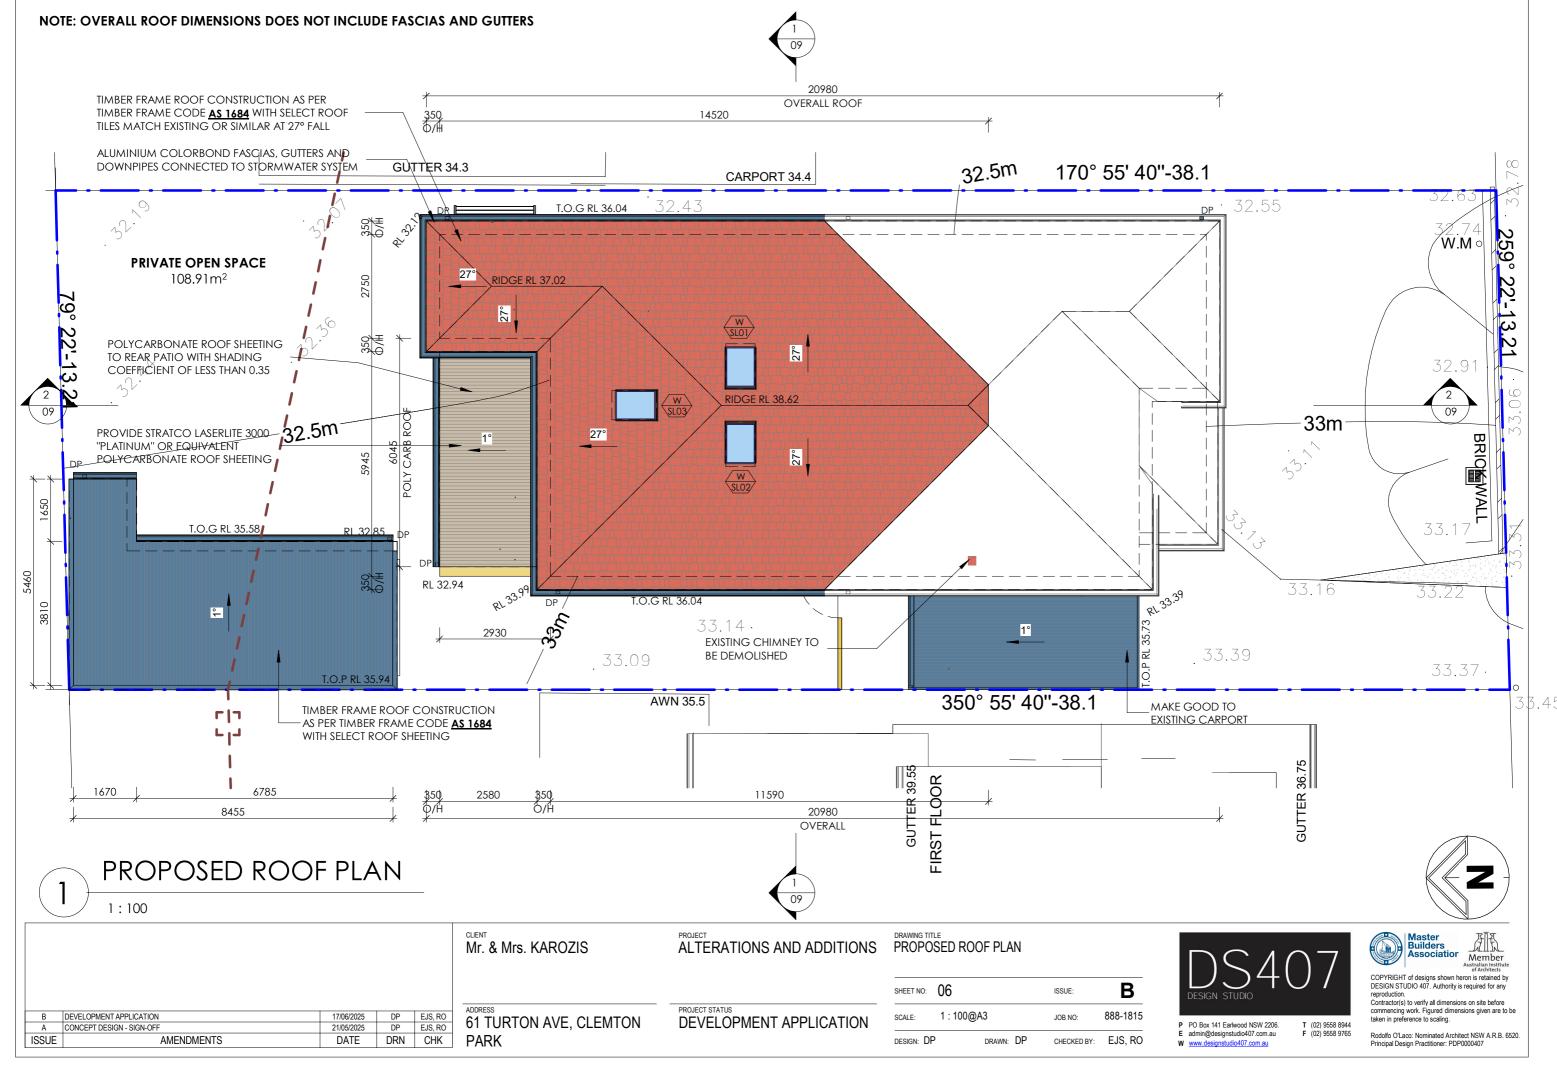
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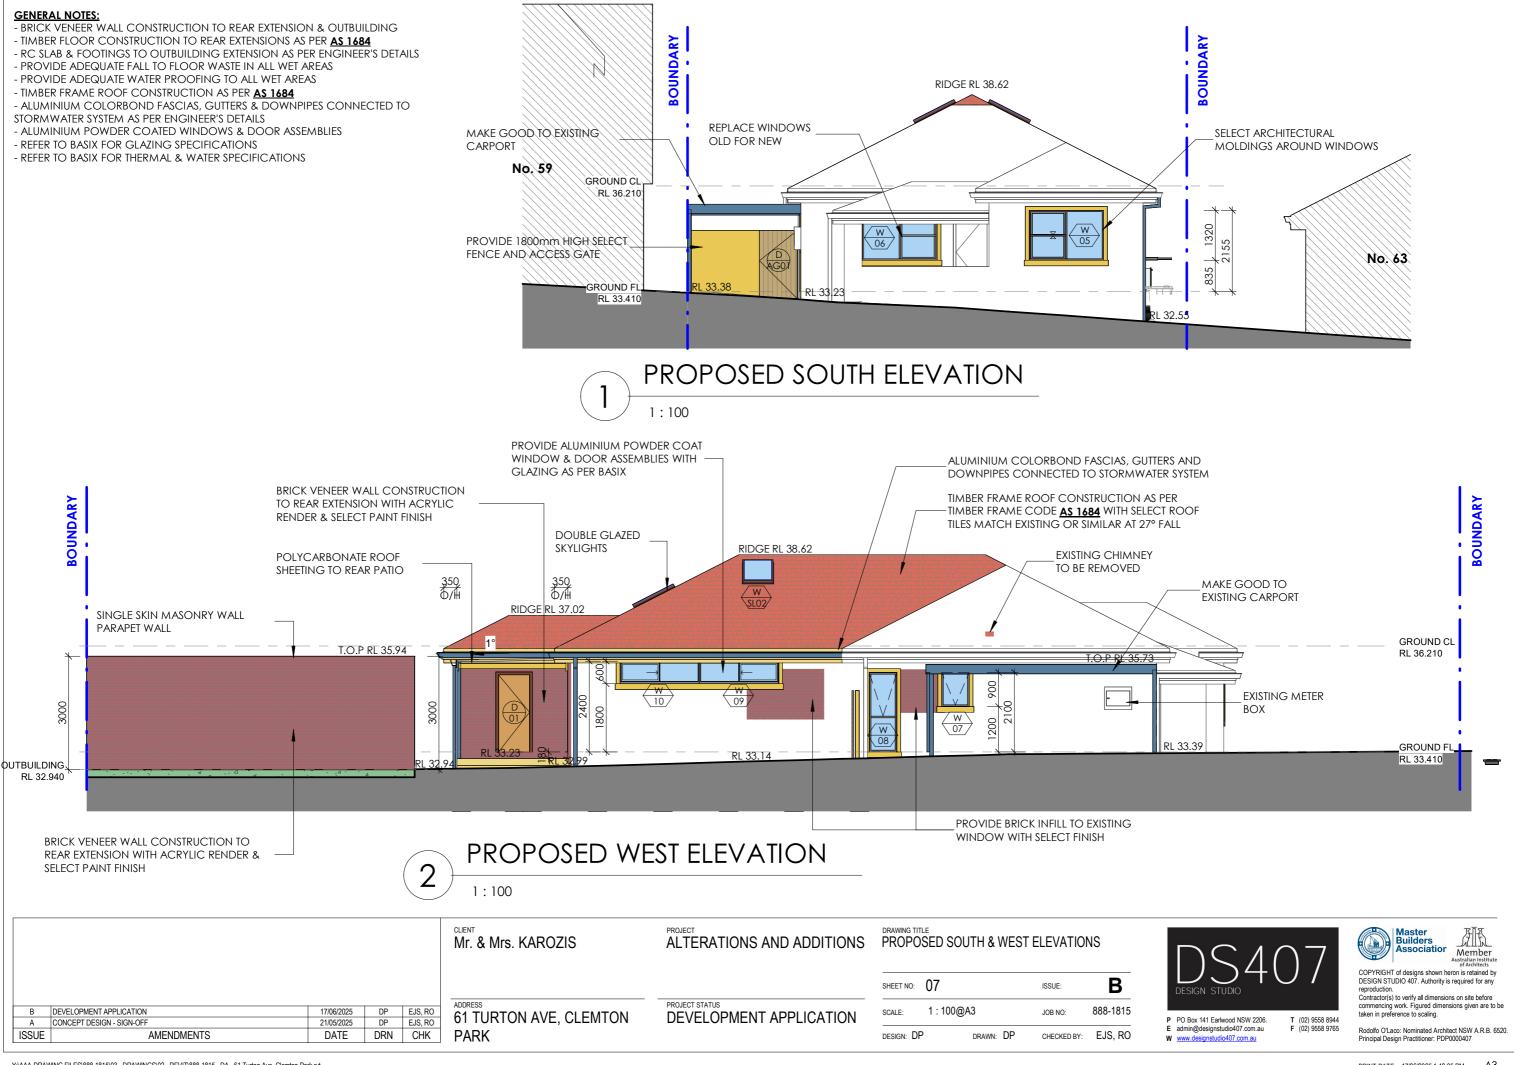
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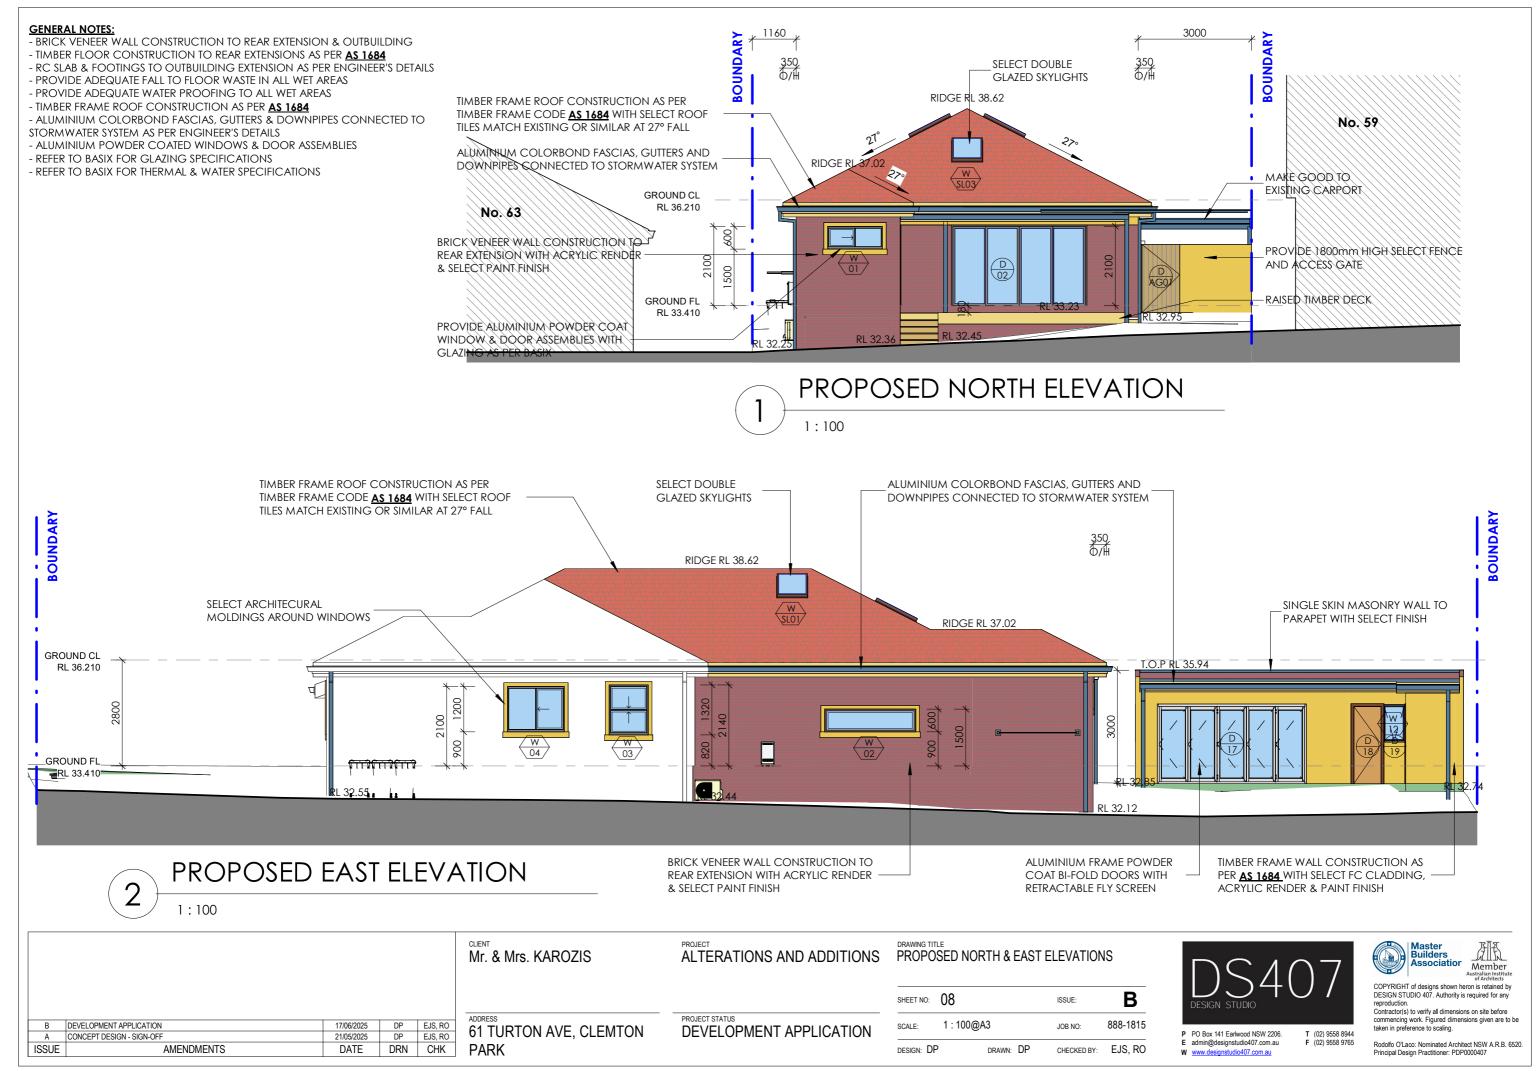
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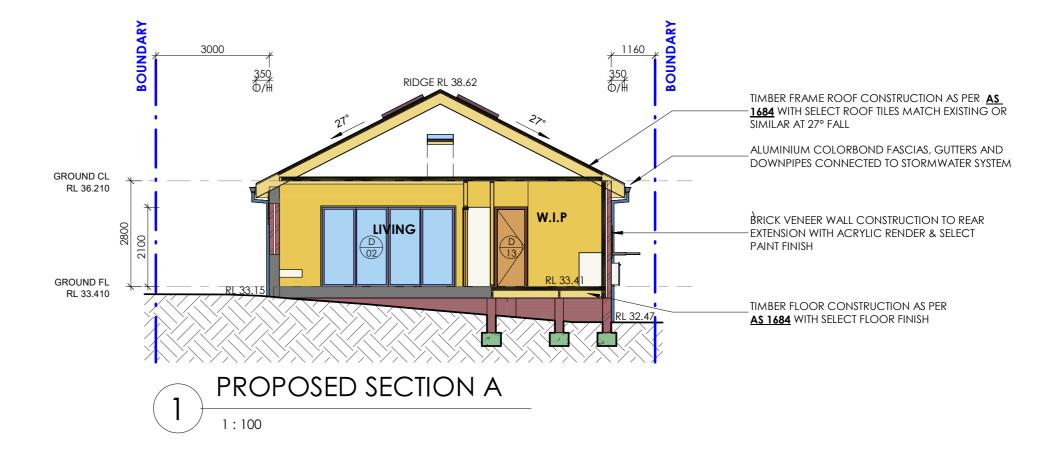







GENERAL NOTES:

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PROPOSED SECTION B

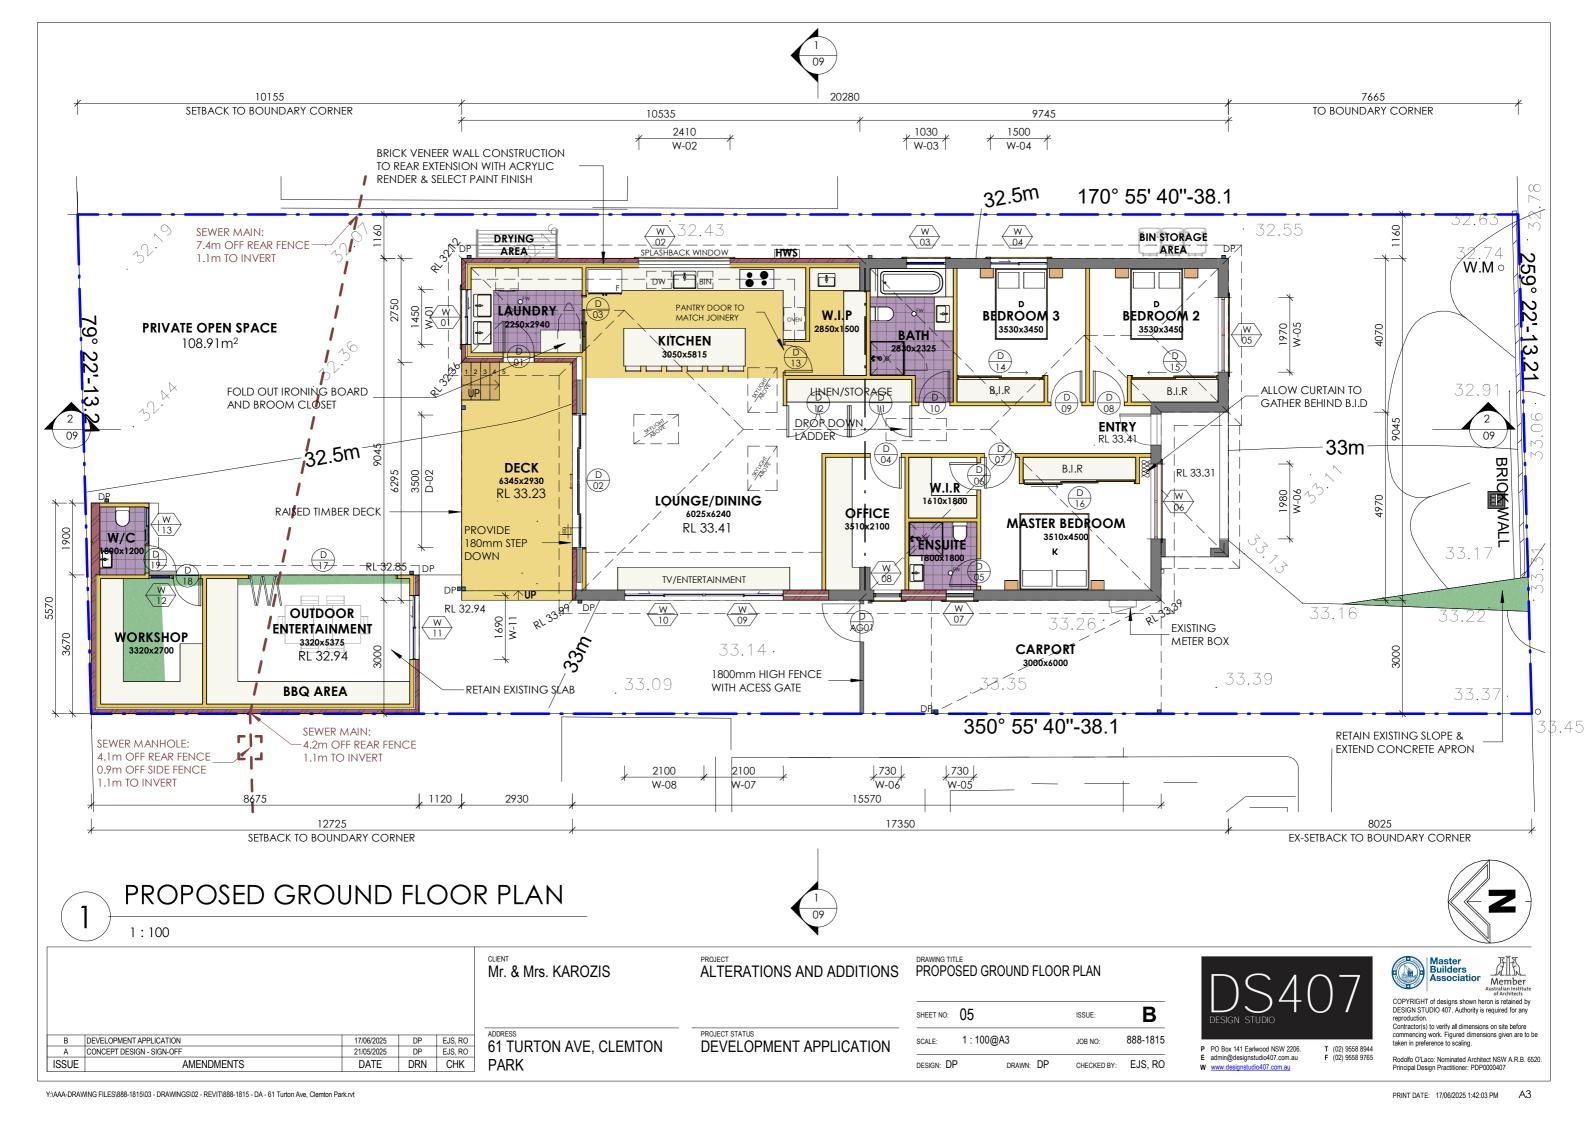1:100
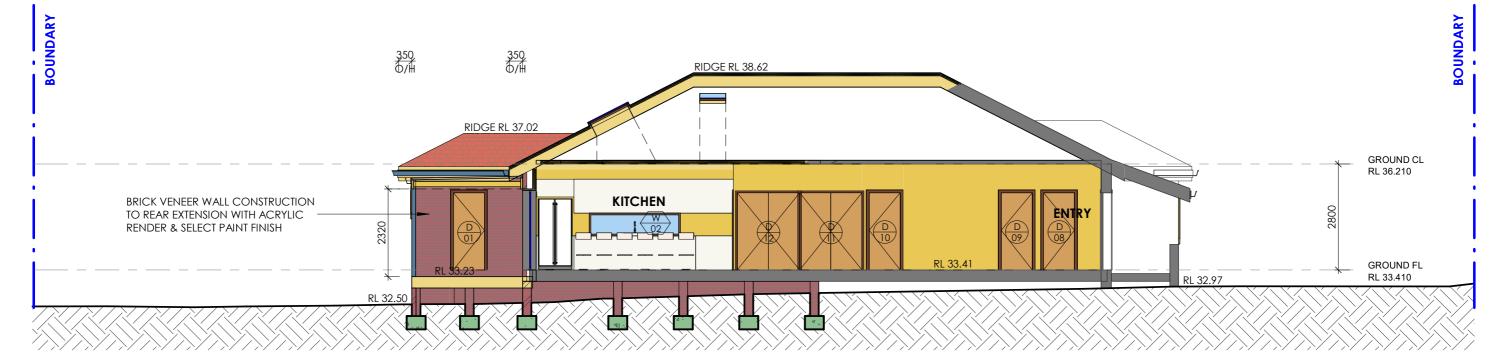
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Mr. & Mrs. KAROZIS

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61 TURTON AVE, CLEMTON

ALTERATIONS AND ADDITIONS

PROJECT STATUS
DEVELOPMENT APPLICATION

SCALE: 1:100@A3

DESIGN: DP DRAWN: DP

PROPOSED SECTION

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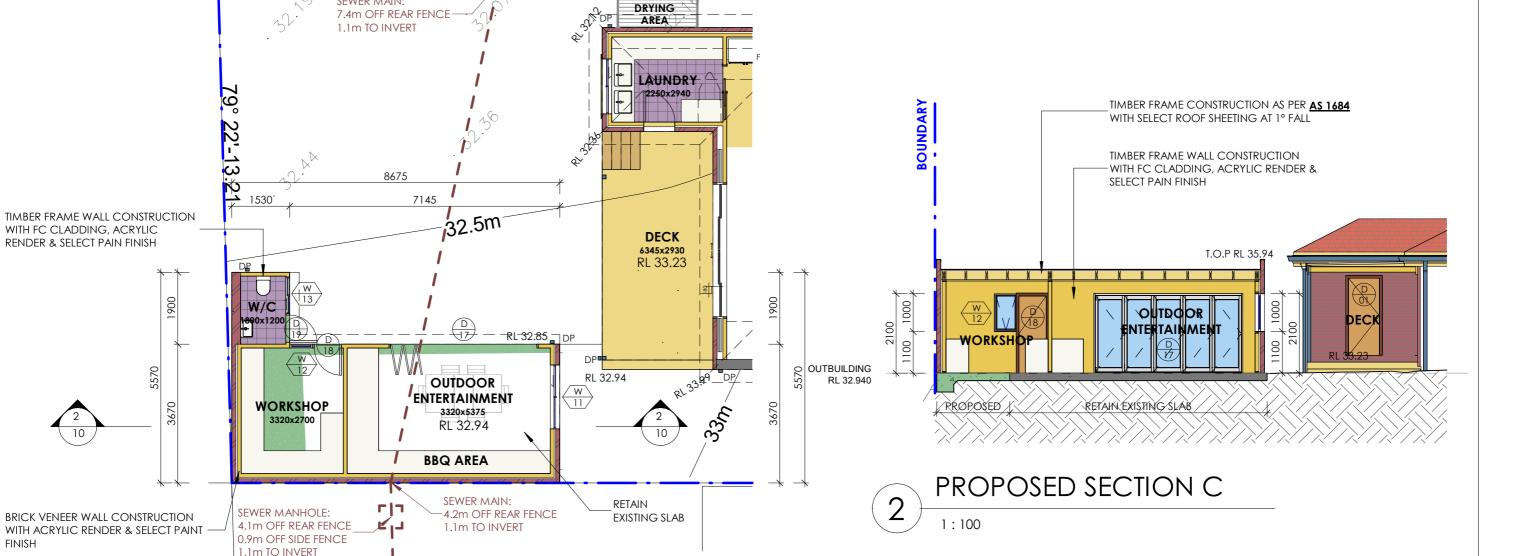
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Rodolfo O'Laco: Nominated Architect NSW A.R.B. 6520. Principal Design Practitioner: PDP0000407

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GENERAL NOTES:

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PROPOSED OUTBUILDING PLAN

PARK

8675 8675

SETBACK TO BOUNDARY CORNER

SEWER MAIN:

1:100

	DELICI ODMENT ADDITION	17/06/2025	DP	EJS, RO
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B A	DEVELOPMENT APPLICATION CONCEPT DESIGN - SIGN-OFF	21/05/2025	DP	EJS, RO

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61 TURTON AVE, CLEMTON

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ALTERATIONS AND ADDITIONS

DEVELOPMENT APPLICATION

PROPOSED OUTBUILDING PLAN & SECTIONS

SHEET NO:	10		ISSUE:	В
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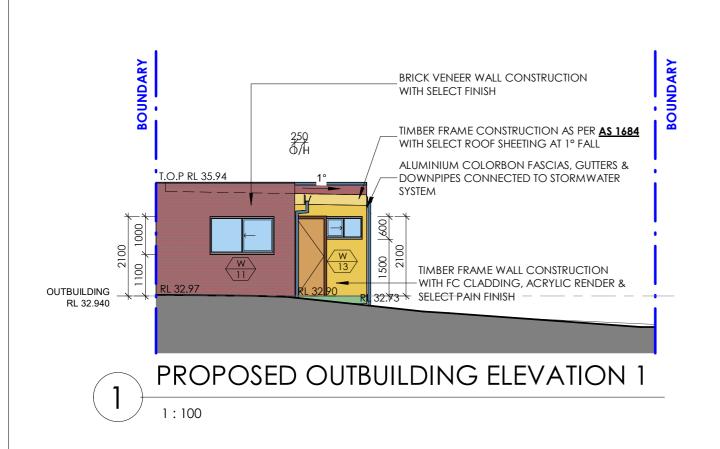
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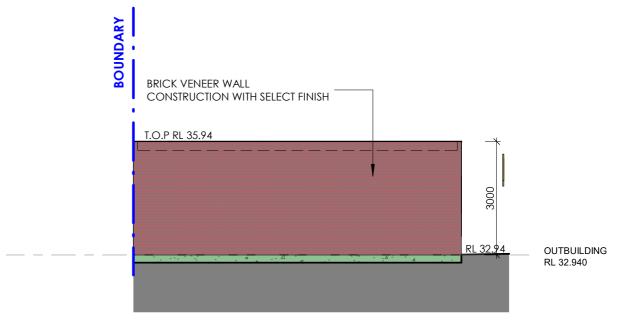
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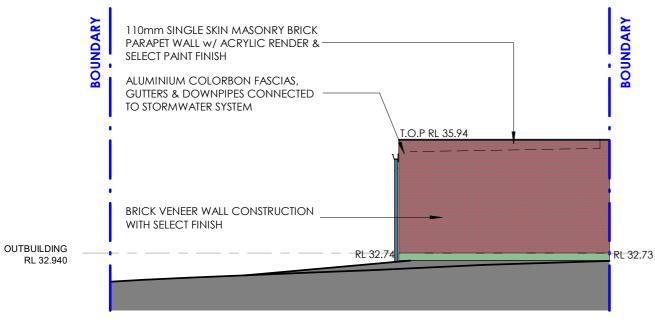
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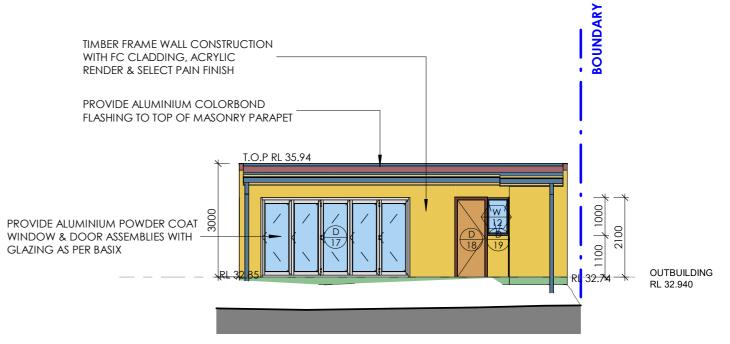
FINISH





PROPOSED OUTBUILDING ELEVATION 2 1:100





PROPOSED OUTBUILDING ELEVATION 3 1:100

PROPOSED OUTBUILDING ELEVATION 4

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ALTERATIONS AND ADDITIONS PROPOSED OUTBUILDING ELEVATIONS

DEVELOPMENT APPLICATION

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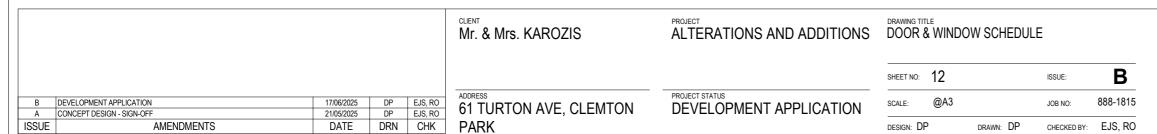
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	DOOR SCHEDULE								
Mark	Height	Width	Door Area	Description	Basix Requirements				
01	2040	820	1.67	Timber Solid Core Internal Single Swing Door	N/A				
02	2100	3500	7.35	Alum. Frame Sliding Door w/ 6.38mm Lam. Clear Glazing	Standard Aluminium, Single Clear, (or U-Value: 7.63, SHGC: 0.75)				
03	2040	720	1.47	Timber Hollow Core Cavity Sliding Door	N/A				
04	2040	820	1.67	Timber Solid Core Internal Single Swing Door	N/A				
05	2040	720	1.47	Timber Solid Core Internal Single Swing Door	N/A				
06	2040	720	1.47	Timber Solid Core Internal Single Swing Door	N/A				
07	2040	820	1.67	Timber Solid Core Internal Single Swing Door	N/A				
08	2040	820	1.67	Timber Solid Core Internal Single Swing Door	N/A				
09	2040	820	1.67	Timber Solid Core Internal Single Swing Door	N/A				
10	2040	820	1.67	Timber Solid Core Internal Single Swing Door	N/A				
11	2040	1650	3.37	Timber Solid Core Internal Double Door	N/A				
12	2040	1650	3.37	Timber Solid Core Internal Double Door	N/A				
13	2040	720	1.47	Timber Solid Core Internal Single Swing Door	N/A				
14	2100	2220	4.66	2 Panel Sliding Wardrobe Doors w/ Select Finish	N/A				
15	2100	2220	4.66	2 Panel Sliding Wardrobe Doors w/ Select Finish	N/A				
16	2100	2900	6.09	3 Panel Sliding Wardrobe Doors w/ Select Finish	N/A				
17	2105	3940	8.29	Alum. Frame Bi-Fold Door w/ 6.38mm Lam. Clear Glazing	N/A				
18	2040	720	1.47	Timber Solid Core Internal Single Swing Door	N/A				
19	2040	720	1.47	Timber Solid Core Internal Single Swing Door	N/A				
AG01	1800	1000	1.80	Select Access Gate	N/A				

	WINDOW SCHEDULE							
Mark	Height	Width	Window Area	Head Height	Description	Basix Requirments		
01	600	1450	0.87	2100	Alum. Frame Sliding Window w/ 6.38mm Lam. Clear Glazing	Standard Aluminium, Single Clear, (or U-Value: 7.63, SHGC: 0.75)		
02	600	2410	1.45	1500	Alum. Frame Fixed Window w/ 6.38mm Lam. Clear Glazing	Standard Aluminium, Single Pyrolytic Low-E, (U-Value: 5.7, SHGC: 0.47)		
03	1320	1030	1.36	2140	Alum. Frame Double Hung Window w/ 6.38mm Lam. Clear Glazing	Standard Aluminium, Single Pyrolytic Low-E, (U-Value: 5.7, SHGC: 0.47)		
04	1200	1500	1.80	2100	Alum. Frame Sliding Window w/ 6.38mm Lam. Clear Glazing	Standard Aluminium, Single Pyrolytic Low-E, (U-Value: 5.7, SHGC: 0.47)		
05	1320	1970	2.60	2155	Alum. Frame Double Hung Window & Fixed Side Light w/ 6.38mm Lam. Clear Glazing	Standard Aluminium, Single Clear, (or U-Value: 7.63, SHGC: 0.75)		
06	1300	1980	2.57	2135	Alum. Frame Double Hung Window & Fixed Side Light w/ 6.38mm Lam. Clear Glazing	Standard Aluminium, Single Clear, (or U-Value: 7.63, SHGC: 0.75)		
07	900	730	0.66	2100	Alum. Frame Awning Window w/ 6.38mm Lam. Clear Glazing	Standard Aluminium, Single Clear, (or U-Value: 7.63, SHGC: 0.75)		
08	2100	730	1.53	2100	Alum. Frame Awning Window w/ 6.38mm Lam. Clear Glazing	Standard Aluminium, Single Pyrolytic Low-E, (U-Value: 5.7, SHGC: 0.47)		
09	600	2100	1.26	2400	Alum. Frame Sliding Window w/ 6.38mm Lam. Clear Glazing	Standard Aluminium, Single Clear, (or U-Value: 7.63, SHGC: 0.75)		
10	600	2100	1.26	2400	Alum. Frame Sliding Window w/ 6.38mm Lam. Clear Glazing	Standard Aluminium, Single Clear, (or U-Value: 7.63, SHGC: 0.75)		
11	1000	1690	1.69	2100	Alum. Frame Sliding Window w/ 6.38mm Lam. Clear Glazing	N/A		
12	1000	610	0.61	2100	Alum. Frame Awning Window w/ 6.38mm Lam. Clear Glazing	N/A		
13	600	970	0.58	2100	Alum. Frame Sliding Window w/ 6.38mm Lam. Clear Glazing	N/A		


	SKYLIGHT SCHEDULE							
Mark	Height	Width	Window Area	Description	Basix Requirments			
SL01	1181	775	0.92	Powdercoated Alum. Frame Skylight	Alum. Frame, Low-E Internal/Argon Fill/Clear External, (or U-Value: 2.9, SHGC: 0.456)			
SL02	1181	775	0.92	Powdercoated Alum. Frame Skylight	Alum. Frame, Low-E Internal/Argon Fill/Clear External, (or U-Value: 2.9, SHGC: 0.456)			
SL03	1181	775	0.92	Powdercoated Alum. Frame Skylight	Alum. Frame, Low-E Internal/Argon Fill/Clear External, (or U-Value: 2.9, SHGC: 0.456)			






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ZONE	R2
SITE AREA	499.5m
FLOOR AREA	
existing dwelling	118.29m
OUTBUILDINGS/GARAGE	20.79m
EXISTING FSR	0.24:
MAX PERMISSIBLE	0.5:
SITE COVERAGE	
hard stand area	137.97m
SOFT LANDSCAPE AREA	13.58m
DEEP SOIL AREA	199.24m
DEEP SOIL %	399
MIN. DEEP SOIL AREA	99.9m
MIN. DEEP SOIL % REQUIRED	209



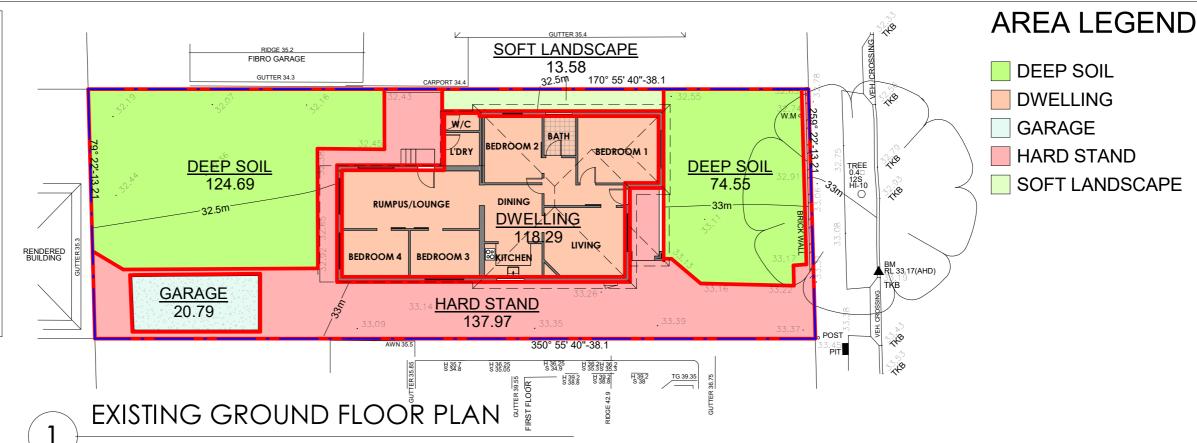



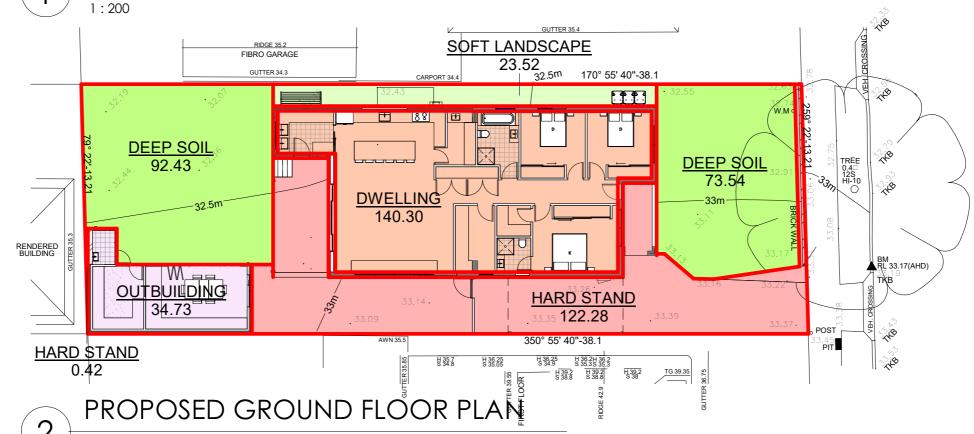

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Α	CONCEPT DESIGN - SIGN-OFF	21/05/2025	DP	EJS, RO
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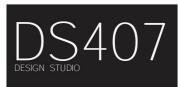
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ALTERATIONS AND ADDITIONS AREA CALCULATIONS

PROJECT STATUS
DEVELOPMENT APPLICATION

SHEET NO:	13	ISSUE:	В
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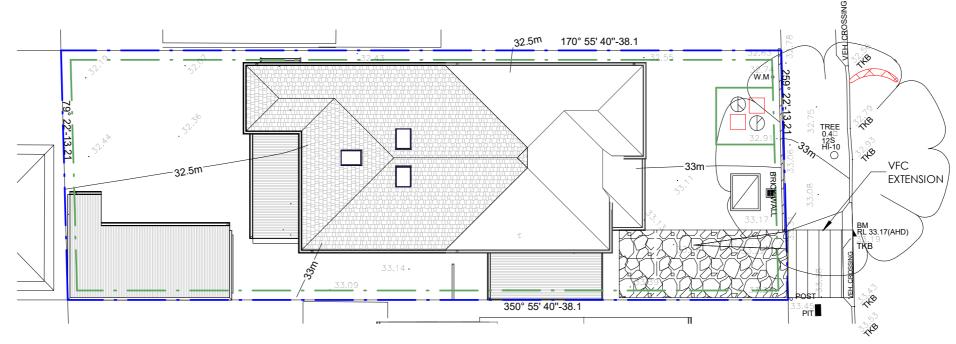
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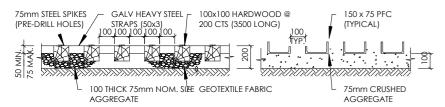
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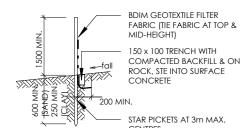


SEDIMENT CONTROL, CONSTRUCTION & WASTE MANAGEMENT PLAN




TYPICAL SHAKEDOWN SECTION

THIS DEVICE IS TO BE REGULARLY CLEANED OF DEPOSITED MATERIAL SO AS TO MAINTAIN A 50mm DEEP SPACE



ALTERNATIVE SECTION

GRID MADE FROM FULLY WELDED 150x75 PFC PERIMETER FRAME WITH 150x75 PEC SPACED AT 100mm. LAID ON 100mm THICK BED OF CRUSHED AGGREGATE.

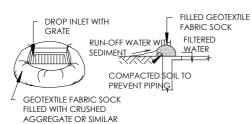

TEMP. SEDIMENT CONTROL FENCE TEMP. DROP INLET SEDIMENT TRAP

- 1. PROVIDE SEDIMENT CONTROL FENCE AT STORMWATER OUTLETS AND DOWNSTREAM BOUNDARIES UNTIL LANDSCAPING, PAVING & TURFING IS COMPLETED.
- 2. MINIMISE BARE EARTH AND DISTURBED AREAS. ALL BARE SOIL AREAS ARE TO BE PROTECTED FROM EROSION BY TEMPORARY MEASURES AND REVEGETATED AT CESSATION OF CONSTRUCTION.
- 3. RETURN OR PROTECT AS SOON AS PRACTICABLE.

DEVELOPMENT APPLICATION

CONCEPT DESIGN - SIGN-OFF

ISSUE

4. COVER ALL SOIL MOUNDS.
5. PROVIDE LARGE COARSE AGGREGATE SURFACE (100 MIN. DEEP) TO ENTRY AND EXIT AREAS WITH GEOTEXTILE FILTER UNDERLAY.

21/05/2025

DATE

DP EJS, RO

DRN CHK

PARK

- S. SATISFACTORILY COMPACT ALL BACKFILL.
- 7 LOCATE ALL DEBRIS IN CATCH AREA BEHIND SEDIMENT FENCE
- 8. REGULARLY CHECK AND MAINTAIN ALL SEDIMENT FEATURES.

ALL EROSION PROTECTION MEASURES TO MEET THE REQUIREMENTS OF COUNCIL & DEPT. OF CONSERVATION AND LAND

SEDIMENT CONTROL DEVICES

FILTER DAMS ARE TO BE CONSTRUCTED AT ALL DRAINAGE OUTLETS WITHIN THE SITE. THESE DAMS SHALL BE CONSTRUCTED AS DETAILED IN THE APPROVED DRAWINGS.
SILT FENCES SHALL BE CONSTRUCTED AS DETAILED IN THE APPROVED DRAWINGS AROUND ALL DISTURBED AREAS,

STOCKPILES AND AS DIRECTED BY THE ENGINEER.

MATERIALS

MATERIALS AND WORKMANSHIP SHALL BE TO THE ENGINEER'S SATISFACTION AND UNLESS OTHERWISE SPECIFIED SHALL CONFORM TO SUCH STANDARD SPECIFICATIONS ISSUED BY THE STANDARDS ASSOCIATION OF AUSTRALIA AS

ROCK BREAKERS / HAMMERS

THE USE OF ANY PNEUMATIC BREAKING OR HAMMERING DEVICE IS NOT PERMITTED FOR THE EXCAVATION OF BEDROCK MATERIAL WITHIN 10 METRES OF EXISTING DWELLINGS OR STRUCTURES.

TRANSPORTATION OF MATERIALS

TRANSPORTATION OF MATERIALS AND OF EARTH, SAND, ROAD CONSTRUCTION MATERIAL, LOOSE DEBRIS AND ANY LOOSE MATFRIALS TO OR FROM THE SITE WILL BE IN A MANNER THAT WILL PREVENT THE DROPPING OF MATERIAL ON THE SURROUNDING STREETS. LOAD COVERS ARE TO BE USED AT ALL TIMES.

SURVEY MARKS

ADEQUATE PRECAUTIONS ARE TO BE TAKEN TO PROTECT AND PRESERVE ANY SURVEY MARK RELATIVE TO OR AFFECTED BY THE DEVELOPMENT.

EARTHWORKS & CLEARING


DURING THE CLEARING, CARE SHALL BE TAKEN NOT TO DISTURB ANY BENCHMARK, SURVEY OR LEVEL PEG. TOPSOIL IS TO BE REMOVED FROM THE WORKS AREA, STOCKPILED AND REPLACED UPON THE DISTURBED AREAS AT THE COMPLETION OF CONSTRUCTION.


VEGETATION PROTECTION

PRIOR TO AND DURING ANY CONSTRUCTION WORKS THE ROOTS, TRUNKS AND BRANCHES OF ALL VEGETATION TO BE RETAINED SHALL BE PROTECTED FROM POLLUTANTS, MACHINERY, CHEMICAL AND FUEL SPILLAGE, COMPACTION OF SURROUNDING SOILS, LEVEL CHANGES WITHIN THE DRIP LINE, STOCKPILING OF SPOIL, AND STOCKPILING OF BUILDING MATERIALS. PROTECTIVE FENCING OF SUCH VEGETATION SHALL BE UNDERTAKEN AS NECESSARY. VEGETATION TO BE LEFT UNDISTURBED OUTSIDE THE APPROVED WORKS AREA.

DESIGN: DP

DRAWN: DP

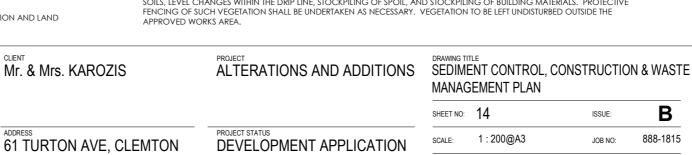

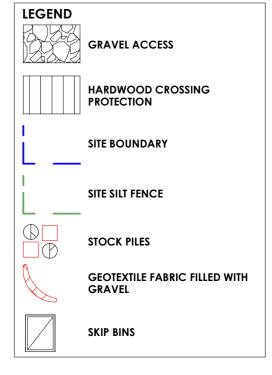



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EJS. RO

CHECKED BY:


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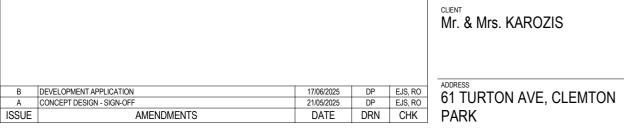
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Rodolfo O'Laco: Nominated Architect NSW A.R.B. 6520. Principal Design Practitioner: PDP0000407

AMENDMENTS






	SHEET NO:	15	ISSUE:	В
PROJECT STATUS DEVELOPMENT APPLICATION			JOB NO:	888-1815
	DESIGN: DF	DRAWN: DP	CHECKED BY:	EJS, RO

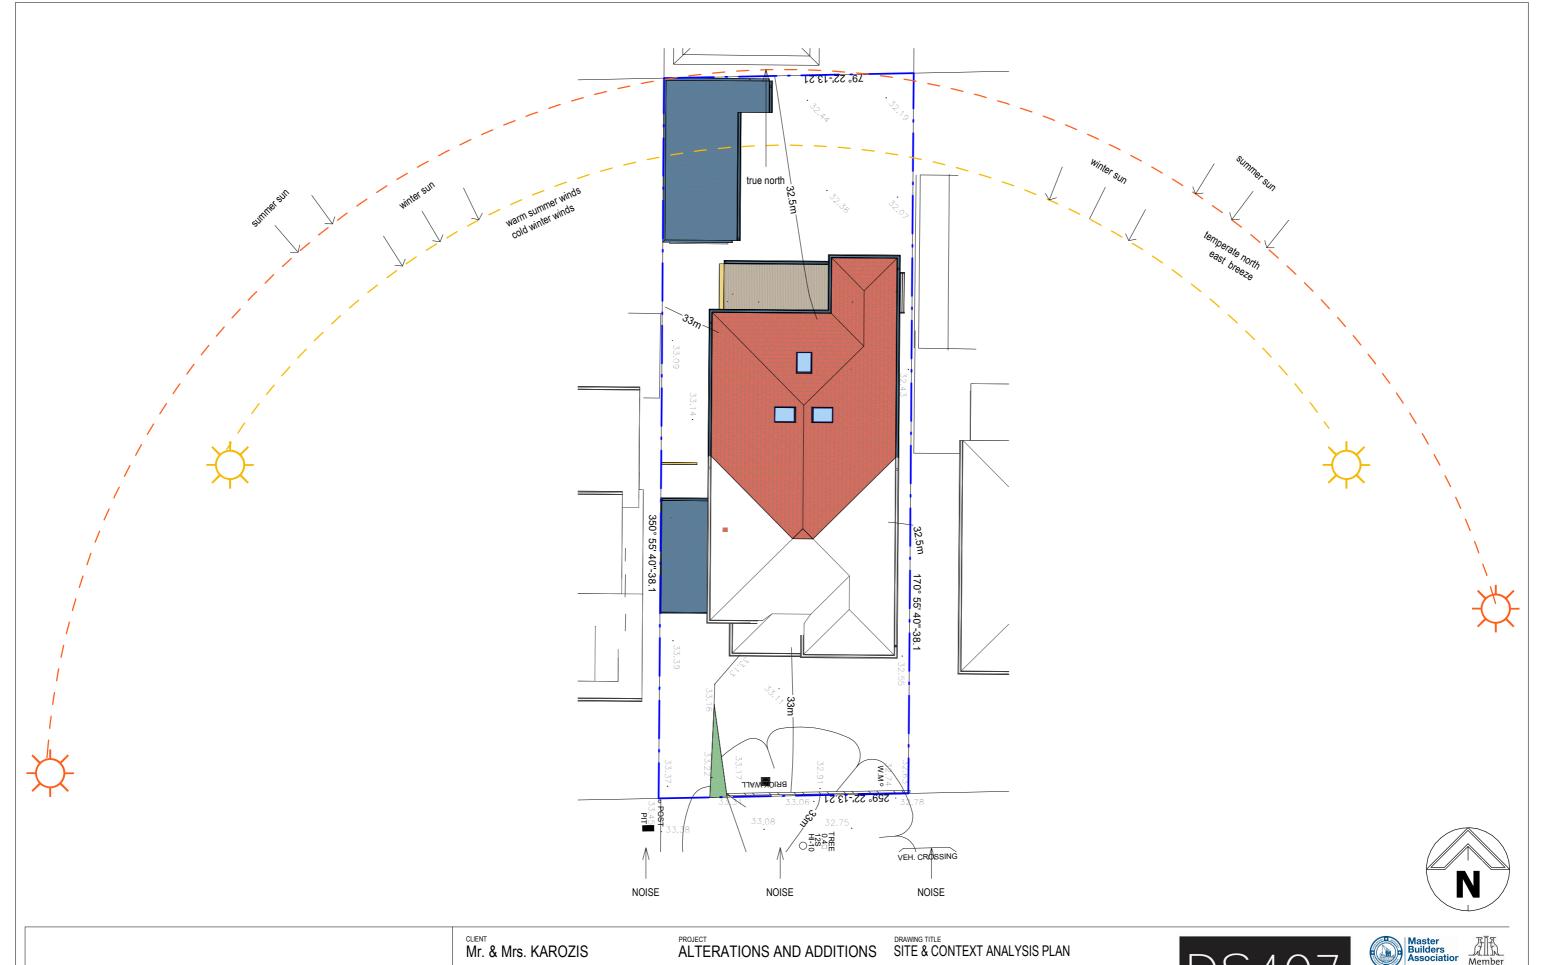

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В	DEVELOPMENT APPLICATION	17/06/2025	UF UF	L00, 110
B A	DEVELOPMENT APPLICATION CONCEPT DESIGN - SIGN-OFF	17/06/2025 21/05/2025	DP	EJS, RO

Mr. & Mrs. KAROZIS

PARK

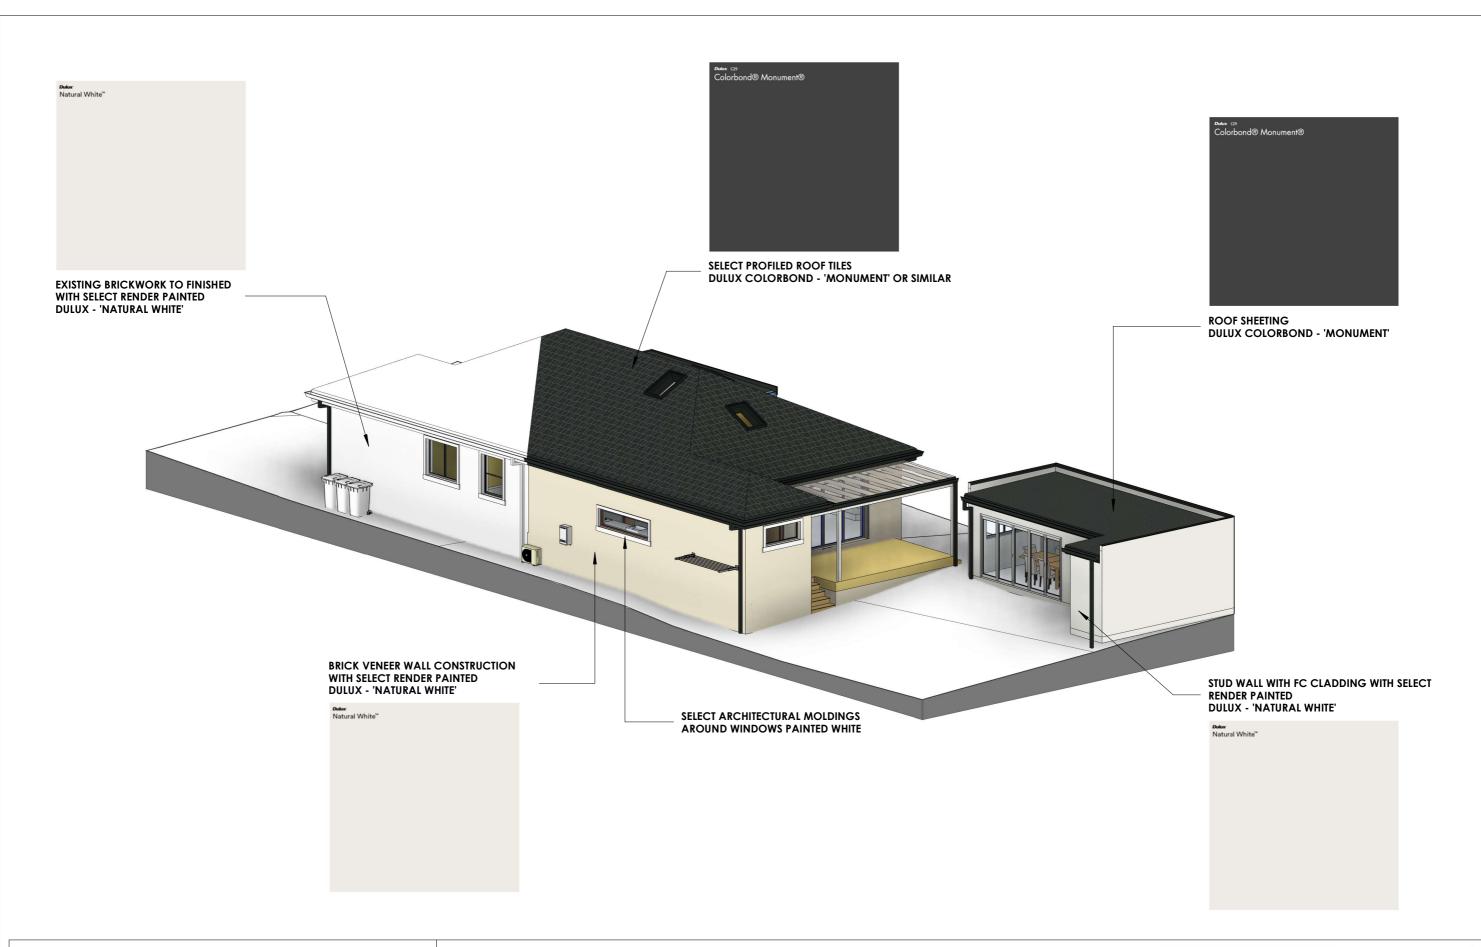61 TURTON AVE, CLEMTON

PROJECT
ALTERATIONS AND ADDITIONS

DRAWING TITLE
FINISHES SCHEDULE

	SHEET NO:	16		ISSUE:	В
PROJECT STATUS DEVELOPMENT APPLICATION	SCALE:	@A3		JOB NO:	888-1815
	DESIGN: DF)	DRAWN: DP	CHECKED BY:	EJS, RO




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			DP	EJS, RO
В	DEVELOPMENT APPLICATION	17/06/2025	01	
B A	DEVELOPMENT APPLICATION CONCEPT DESIGN - SIGN-OFF	17/06/2025 21/05/2025	DP	EJS, RO

Mr.	&	Mrs.	KAROZIS

PARK

61 TURTON AVE, CLEMTON

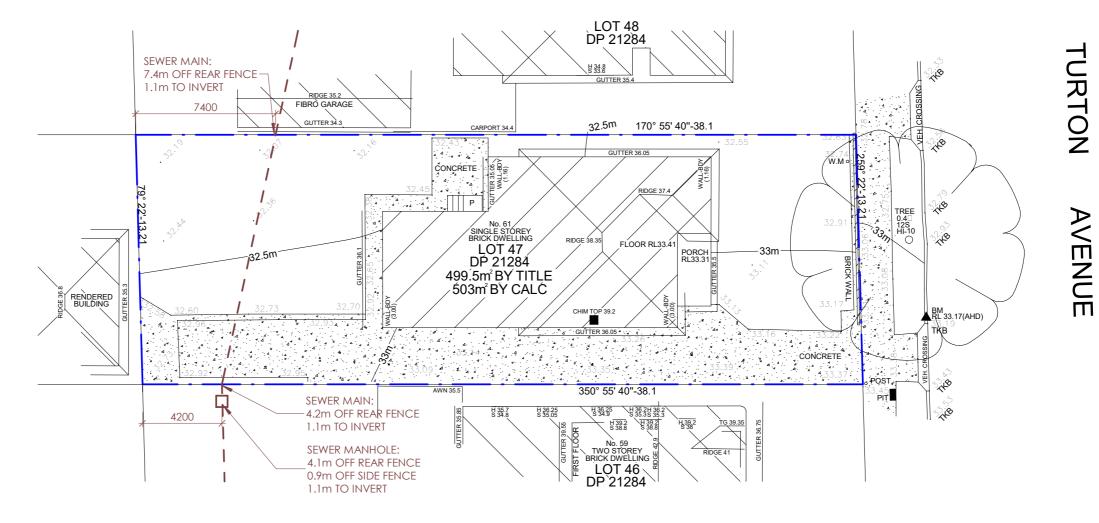ALTERATIONS AND ADDITIONS

PROJECT STATUS
DEVELOPMENT APPLICATION
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PEG-OUT		

SHEET NO:	17		IS	SSUE:	В
SCALE:	1:200@A3		JO	OB NO:	888-1815
DESIGN: DF	DR/	AWN: DP	С	HECKED BY:	EJS, RO



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r rs iatior Member

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BASIX™Certificate

Building Sustainability Index www.planningportal.nsw.gov.au/development-and-assessment/basix

Alterations and Additions

Certificate number: A1798872

This certificate confirms that the proposed development will meet the NSW government's requirements for sustainability, if it is built in accordance with the commitments set out below. Terms used in this certificate, or in the commitments, have the meaning given by the document entitled "BASIX Definitions" dated 10/09/2020 published by the Department. This document is available at www.planningportal.nsw.gov.au/definitions

Secretary
Date of Issue: Friday, 06 June 2025
To be valid, this certificate must be lodged within 3 months of the date of Issue.



Certificate Prepared by (pl Name / Company Name: Building &	ease complete before submitting to Council or PCA)
N/A	N/A
Type of alteration and addition	The estimated development cost for my renovation work is \$50,000 or more, and does not include a pool (and/or spa).
Dwelling type	Dwelling house (detached)
Project type	
Section number	-
Lot number	47
Plan type and number	Deposited Plan DP21284
Local Government Area	Canterbury-Bankstown Council
Street address	61 TURTON Avenue CLEMTON PARK 2206
Project name	61 TURTON AVE

Fixtures and systems	Show on DA Plans	Show on CC/CDC Plans & specs	Certifier Check
Lighting			
The applicant must ensure a minimum of 40% of new or altered light fixtures are fitted with fluorescent, compact fluorescent, or light-emitting-diode (LED) lamps.		~	~
Fixtures			
The applicant must ensure new or altered showerheads have a flow rate no greater than 9 litres per minute or a 3 star water rating.		~	~
The applicant must ensure new or altered toilets have a flow rate no greater than 4 litres per average flush or a minimum 3 star water rating.		~	~
The applicant must ensure new or altered taps have a flow rate no greater than 9 litres per minute or minimum 3 star water rating.		~	

Construction	Show on DA Plans	Show on CC/CDC Plans & specs	Certifier Check		
nsulation requirements					
The applicant must construct the new or alte listed in the table below, except that a) addi insulation specified is not required for parts	~	~	~		
Construction	Additional insulation required (R-value)	Other specifications			
suspended floor with enclosed subfloor: framed (R0.7).	R0.60 (down) (or R1.30 including construction)	N/A			
external wall: cavity brick	nil				
CALCITICIT Wall. Cavity blick					
external wall: brick veneer	R1.16 (or R1.70 including construction)				

Glazing requirements	Show on DA Plans	Show on CC/CDC Plans & specs	Certifie Check
Windows and glazed doors			
The applicant must install the windows, glazed doors and shading devices, in accordance with the specifications listed in the table below. Relevant overshadowing specifications must be satisfied for each window and glazed door.	~	~	~
The following requirements must also be satisfied in relation to each window and glazed door:		~	~
Each window or glazed door with standard aluminium or timber frames and single clear or toned glass may either match the description, or, have a U-value and a Solar Heat Gain Coefficient (SHGC) no greater than that listed in the lable below. Total system U-values and SHGCs must be calculated in accordance with National Fenestration Rating Council (NFRC) conditions.		~	~
Each window or glazed door with improved frames, or pyrolytic low-e glass, or cleariair gapiclear glazing, or toned/air gapiclear glazing must have a U-value and a Solar Heat Gain Coefficient (SHGC) no greater than that listed in the table below. Total system U-values and SHGCs must be calculated in accordance with National Fenestration Rating Council (NFRC) conditions. The description is provided for information only. Alternative systems with complying U-value and SHGC may be substituted.		~	~
For projections described in millimetres, the leading edge of each eave, pergola, verandah, balcony or awning must be no more than 500 mm above the head of the window or glazed door and no more than 2400 mm above the sill.	~	~	~
For projections described as a ratio, the ratio of the projection from the wall to the height above the window or glazed door sill must be at least that shown in the table below.	~	~	~
Pergolas with polycarbonate roof or similar translucent material must have a shading coefficient of less than 0.35.		~	~
Pergolas with fixed battens must have battens parallel to the window or glazed door above which they are situated, unless the pergola also shades a perpendicular window. The spacing between battens must not be more than 50 mm.		~	~
Overshadowing buildings or vegetation must be of the height and distance from the centre and the base of the window and glazed door, as specified in the 'overshadowing' column in the table below.	~	~	~

Glazing requir	ements						Show on DA Plans	Show on CC/CDC Plans & specs	Certifier Check
Vindows and gla	zed doors glazing	requirements							
Window/door number	Orientation	Area of glass including frame (m2)	Overshadowing height (m)	Overshadowing distance (m)	Shading device	Frame and glass type			
W1	N	0.87	0	0	projection/ height above sill ratio >=0.43	standard aluminium, single clear, (or U-value: 7.63, SHGC: 0.75)			
W2	Е	1.45	0	0	projection/ height above sill ratio >=0.29	standard aluminium, single pyrolytic low-e, (U- value: 5.7, SHGC: 0.47)			
W3	Е	1.36	0	0	projection/ height above sill ratio >=0.29	standard aluminium, single pyrolytic low-e, (U- value: 5.7, SHGC: 0.47)			
W4	Е	1.8	0	0	projection/ height above sill ratio >=0.29	standard aluminium, single pyrolytic low-e, (U- value: 5.7, SHGC: 0.47)			
W5	S	2.6	0	0	projection/ height above sill ratio >=0.29	standard aluminium, single clear, (or U-value: 7.63, SHGC: 0.75)			

Glazing requir	ements						Show on DA Plans	Show on CC/CDC Plans & specs	Certifier Check
Window/door number	Orientation	Area of glass including frame (m2)	Overshadowing height (m)	Overshadowing distance (m)	Shading device	Frame and glass type			
W6	s	2.57	0	0	projection/ height above sill ratio >=0.43	standard aluminium, single clear, (or U-value: 7.63, SHGC: 0.75)			
W7	W	0.66	0	0	projection/ height above sill ratio >=0.43	standard aluminium, single clear, (or U-value: 7.63, SHGC: 0.75)			
W8	w	1.53	2.44	4.1	eave/ verandah/ pergola/balcony >=450 mm	standard aluminium, single pyrolytic low-e, (U- value: 5.7, SHGC: 0.47)			
W9	W	1.26	0	0	projection/ height above sill ratio >=0.43	standard aluminium, single clear, (or U-value: 7.63, SHGC: 0.75)			
W10	w	1.26	0	0	projection/ height above sill ratio >=0.43	standard aluminium, single clear, (or U-value: 7.63, SHGC: 0.75)			

							Show on DA Plans	Show on CC/CDC Plans & specs	Certifier Check
Windows and glaz	zed doors glazing	requirements							
Window/door number	Orientation	Area of glass including frame (m2)	Overshadowing height (m)	Overshadowing distance (m)	Shading device	Frame and glass type			
D02	N	7.35	0	0	eave/ verandah/ pergola/balcony >=900 mm	standard aluminium, single clear, (or U-value: 7.63, SHGC: 0.75)			

Glazing requirements	Show on DA Plans	Show on CC/CDC Plans & specs	Certifie Check			
Skylights						
The applicant must install the	skylights in accordance with the spe-	cifications listed in the table I	pelow.	~	~	~
The following requirements m	nust also be satisfied in relation to each	th skylight:			~	~
Each skylight may either mate listed in the table below.	ch the description, or, have a U-value	and a Solar Heat Gain Coef	ficient (SHGC) no greater than that		~	~
Skylights glazing requirement	ents					
Skylight number	Area of glazing inc. frame (m2)	Shading device	Frame and glass type			
S1	0.92	no shading	timber, low-E internal/argon fill/clear external, (or U-value: 2.9, SHGC: 0.456)			
S2	0.92	no shading	timber, low-E internal/argon fill/clear external, (or U-value: 2.9, SHGC: 0.456)			
\$3	0.92	no shading	timber, low-E internal/argon fill/clear external, (or U-value: 2.9, SHGC: 0.456)			

В	DEVELOPMENT APPLICATION	17/06/2025	DP	EJS, RO
Α	CONCEPT DESIGN - SIGN-OFF	21/05/2025	DP	EJS, RO
ISSUE	AMENDMENTS	DATE	DRN	CHK

Mr. & Mrs. KAROZIS

PARK

61 TURTON AVE, CLEMTON

ALTERATIONS AND ADDITIONS

SHEET NO: 18 SCALE: DEVELOPMENT APPLICATION

BASIX


В ISSUE: 888-1815 JOB NO: DRAWN: DP DESIGN: DP CHECKED BY: EJS, RO



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3D PERSPECTIVE 2

B DEVELOPMENT APPLICATION 17/06/2025 DP EJS, RO A CONCEPT DESIGN - SIGN-OFF 21/05/2025 DP EJS, RO ISSUE AMENDMENTS DATE DRN CHK					
A CONCEPT DESIGN - SIGN-OFF 21/05/2025 DP EJS, RO					
	В	DEVELOPMENT APPLICATION	17/06/2025	DP	EJS, RO
ISSUE AMENDMENTS DATE DRN CHK	Α	CONCEPT DESIGN - SIGN-OFF	21/05/2025	DP	EJS, RO
	ISSUE	AMENDMENTS	DATE	DRN	CHK

Mr. & Mrs. KAROZIS

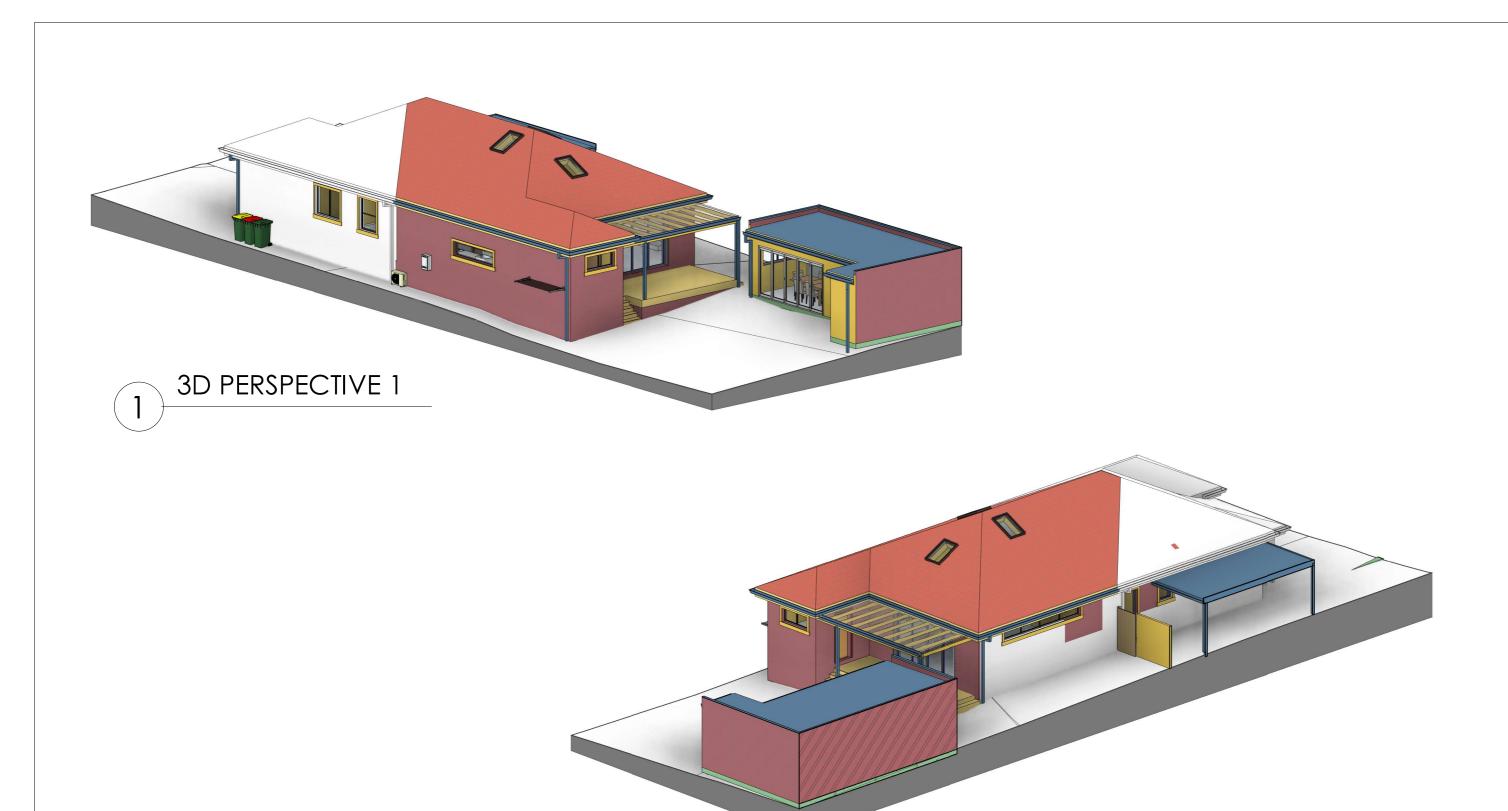PARK

61 TURTON AVE, CLEMTON

ALTERATIONS AND ADDITIONS DRAWING TITLE PERSPECTIVES

PROJECT STATUS
DEVELOPMENT APPLICATION

В SHEET NO: 19 ISSUE: 888-1815 SCALE: DESIGN: DP DRAWN: DP CHECKED BY: EJS, RO

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